


# STORMWATER DRAINAGE PLAN

SCALE 1:100 (1:200@A3)

|  |  | DRAWN: HM       | DESIGNED: DM   | PROJECT:                               | CLIENT:          |
|--|--|-----------------|----------------|--|------------------|
|  | DATE   | APPROVED:       | DATE: 10/05/22 | PROPOSED ALTERATIONS AND ADDITIONS     | JERRY A          |
|  | 10/05/22 DANNY MORCHED<br>B.E CIVIL<br>M.E STRUCTURAL<br>CPEng,MIEAust,NPER<br>MEMB. NO: 2320868 |                 | D              | 6 JOHNSTON STREET<br>EARLWOOD NSW 2206 |                  |
|  |  |                 |                |  | TITLE:<br>STORMW |
|  |  | SCALE AT A1: 1: | :100 UNO       |  | ••••             |

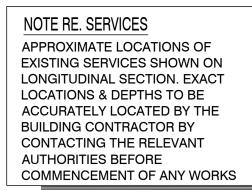



## NOTES

LET

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21 K


B


KER


- 1. ALL LINES ARE TO BE MIN. 100Ø UPVC @ MIN 1.0% GRADE UNLESS NOTED OTHERWISE.
- 2. IT IS THE CONTRACTORS RESPONSIBILITY TO LOCATE & LEVEL ALL EXISTING SERVICES PRIOR TO THE COMMENCEMENT OF ANY EARTHWORKS. ALL DESIGN LEVELS SHOWN ON PLAN SHALL BE VERIFIED ON SITE PRIOR TO THE COMMENCEMENT OF ANY WORK.
- 3. ALL PIPES TO HAVE MIN 200mm COVER IF LOCATED WITHIN PROPERTY.
- 4. ALL PITS IN DRIVEWAYS BE HEAVY DUTY GRATES. DIRECT SURFACE FLOW TO ALL GRATED SURFACE INLET PITS.
- 5. ALL WORK DO BE DONE IN ACCORDANCE WITH AS/NZ 3500.3.2:2003 AND COUNCIL SPECIFICATIONS.
- 6. LOCATION OF DOWNPIPES & FLOOR WASTES ARE INDICATIVE ONLY. DOWNPIPE & FLOOR WASTE SIZE, LOCATION & QUANTITY TO BE DETERMINED BY BUILDER & IN ACCORDANCE WITH RELEVANT AUSTRALIAN STANDARDS.
- 7. THIS PLAN IS TO BE READ IN CONJUNCTION WITH THE ARCHITECTURAL, LANDSCAPE AND STRUCTURAL PLANS.
- 8. ANY DISCREPANCIES OR OMISSIONS SHALL BE REFERRED TO THE DESIGN ENGINEER FOR RESOLUTION.
- 9. ALL PITS OR GRATES IN TRAFFICABLE AREAS TO BE HEAVY DUTY.
- 10. ALL GUTTERS WILL BE FITTED WITH LEAF GUARDS AND SHOULD BE INSPECTED AND CLEANED TO ENSURE LEAF LITTER CANNOT ENTER THE DOWNPIPES

| SYMBOLS                    |   |  |  |
|----------------------------|---|--|--|
| F.F.L.<br>T.K.<br>RL<br>IL | FINISHED FLOOR LEVEL<br>TOP OF KERB<br>PIT SURFACE LEVEL<br>INVERT LEVEL<br>STORMWATER DRAINAGE PIPE              |  |  |
| • DP<br>◀ SP<br>● IO       | DOWNPIPE TO RAINWATER TANK<br>100Ø DOWN PIPE (U.N.O.)<br>SPREADER<br>INSPECTION OPENING<br>MASONRY RETAINING WALL |  |  |
| ⊗ FW                       | FLOOR WASTE 150Ø  |  |  |
|                            | GRATED INLET PIT<br>GRATED DRAIN  |  |  |
| ES—                        | OVERLAND FLOW PATH<br>EMERGENCY SPILTTER  |  |  |
| VD●<br>● EDP               | VERTICAL DROP<br>EXISTING 100Ø DOWN PIPE (U.N.O.)<br>EXISTING STORMWATER DRAINAGE                                 |  |  |

ALL DIMENSIONS IN 'mm' UNLESS OTHERWISE STATED AND ANNE JOB NO. D22123 WATER DRAINAGE PLAN DRAWING NO. ST01

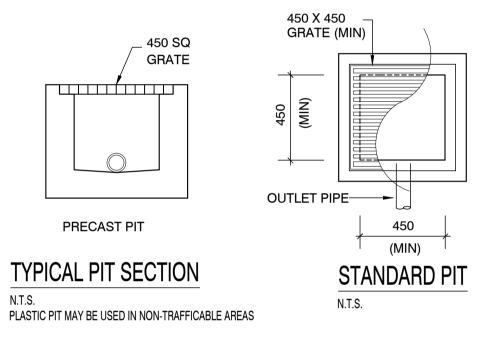


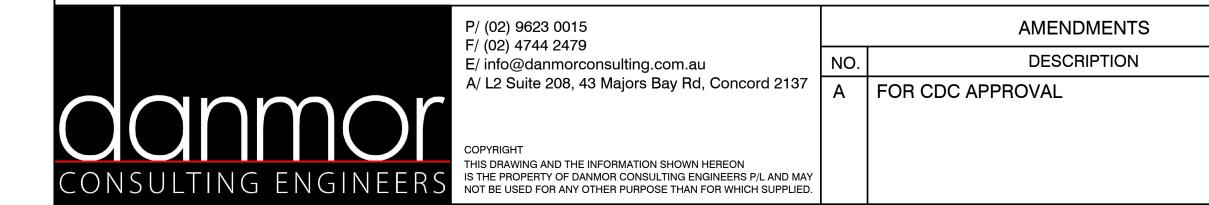

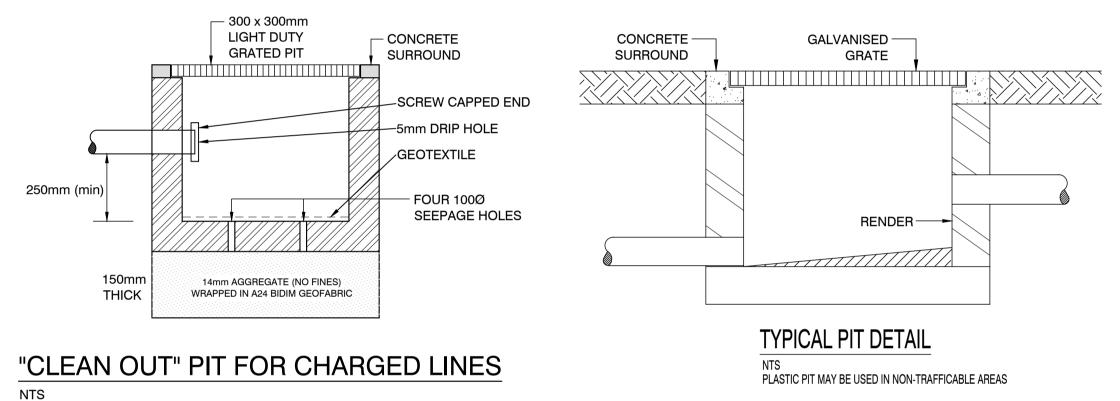

PLASTIC PIT MAY BE USED IN NON-TRAFFICABLE AREAS

|  |                  | DRAWN: HM                               | DESIGNED: DM        | PROJECT:                           | CLIENT: |
|--|------------------|---|---------------------|------------------------------------|---------|
|  | DATE<br>10/05/22 | APPROVED:<br>DANNY MORCHE               | DATE: 10/05/22<br>D | PROPOSED ALTERATIONS AND ADDITIONS | JERRY / |
|  |                  | B.E CIVIL<br>M.E STRUCTURAL             |                     | 6 JOHNSTON STREET                  | TITLE:  |
|  |                  | CPEng,MIEAust,NPER<br>MEMB. NO: 2320868 |                     | EARLWOOD NSW 2206                  | STORM   |
|  |                  | SCALE AT A1: 1                          | :100 UNO            |                                    |         |

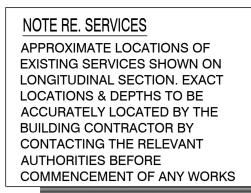





## NOTES

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| AND ANNE               | ALL DIMENSIONS IN 'mm'<br>UNLESS OTHERWISE STATED |  |
|------------------------|---|--|
|                        | ЈОВ NO.<br>D22123                                 |  |
| WATER DRAINAGE DETAILS | DRAWING NO.<br>ST02                               |  |

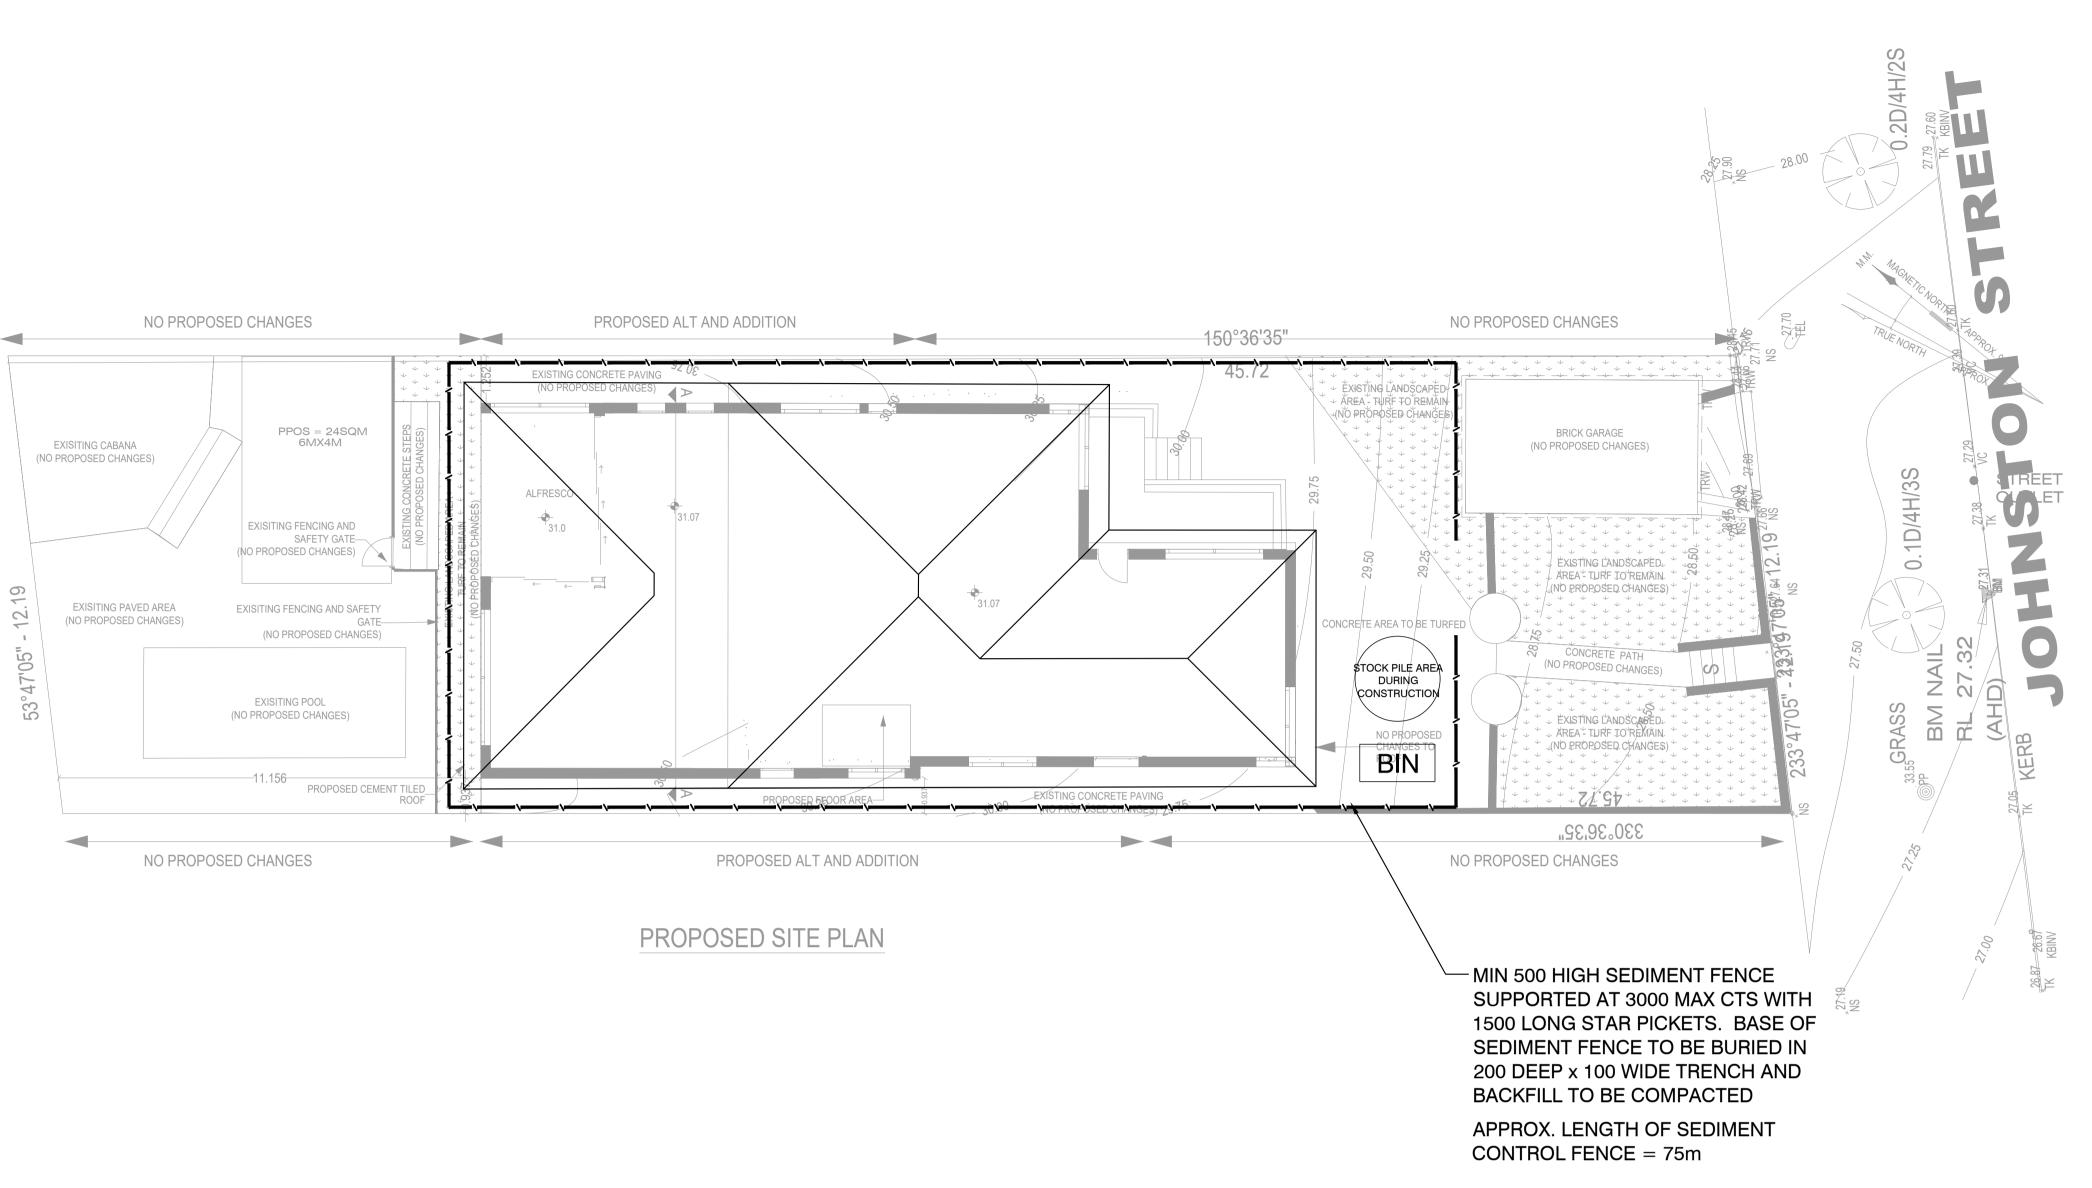

NOT BE USED FOR ANY OTHER PURPOSE THAN FOR WHICH SUPPLIED.

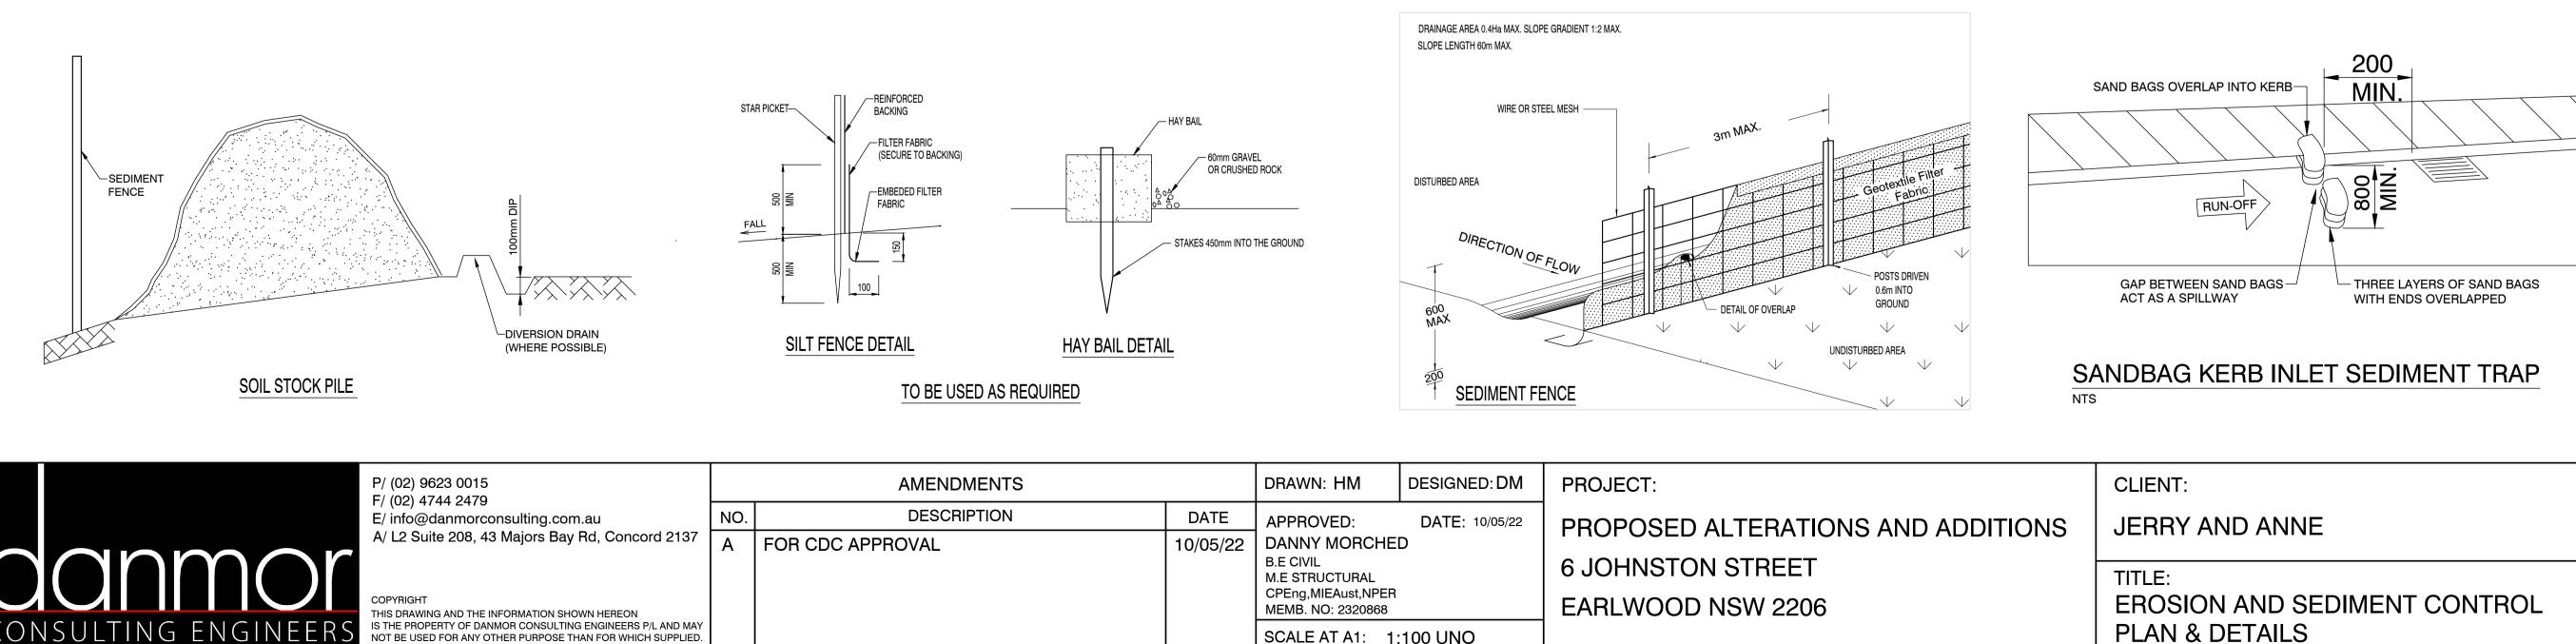

# EROSION AND SEDIMENT CONTROL PLAN

SCALE 1:100

|                             | DRAWN: HM                               | DESIGNED: DM   | PROJECT:                           | CLIENT:                      | ALL DIMENSIONS IN 'mm'  |
|-----------------------------|---|----------------|------------------------------------|------------------------------|-------------------------|
| DATE                        | APPROVED:                               | DATE: 10/05/22 | PROPOSED ALTERATIONS AND ADDITIONS | JERRY AND ANNE               | UNLESS OTHERWISE STATED |
| 10/05/22                    |   |                | 6 JOHNSTON STREET                  |                              | JOB NO.                 |
| B.E CIVIL<br>M.E STRUCTURAL |   |                |                                    | TITLE:                       | D22123                  |
|                             | CPEng,MIEAust,NPER<br>MEMB. NO: 2320868 |                | EARLWOOD NSW 2206                  | EROSION AND SEDIMENT CONTROL | DRAWING NO.             |
|                             | SCALE AT A1: 1:                         | 100 UNO        |                                    | PLAN & DETAILS               | ST03                    |

## EROSION CONTROL NOTES

- 1. ALL EROSION & SEDIMENT CONTROL MEASURES ARE TO BE INSTALLED AND MAINTAINED IN ACCORDANCE WITH 'MANAGING URBAN STORMWATER, 3rd EDITION' PRODUCED BY THE NSW DEPARTMENT OF HOUSING.
- 2. ALL EROSION AND SILTATION CONTROL DEVICES ARE TO BE PLACED PRIOR TO THE COMMENCEMENT OF ANY CONSTRUCTION WORKS, AND ALL SILT TRAPS ARE TO HAVE DEPOSITED SILT REMOVED REGULARLY DURING CONSTRUCTION
- 3. ALL TREES ARE TO BE PRESERVED UNLESS INDICATED OTHERWISE ON THE ARCHITECT'S OR LANDSCAPE ARCHITECT'S DRAWINGS. EXISTING GRASS COVER SHALL BE MAINTAINED EXCEPT IN AREAS CLEARED FOR BUILDINGS, PAVEMENTS ETC.
- 4. INSTALL TEMPORARY SEDIMENT BARRIERS TO ALL INLET PITS LIKELY TO COLLECT SILT LADDEN WATER
- 5. NOT WITHSTANDING DETAILS SHOWN IT IS THE CONTRACTORS SOLE RESPONSIBILITY TO ENSURE THAT ALL SITE ACTIVITIES COMPLY WITH THE REQUIREMENTS OF THE CLEAN WATERS ACT.

### SYMBOLS

|    | EXISTING CONTOURS |
|----|-------------------|
| // | SILT FENCE        |
|    | WIRE MESH FENCE   |

Ø50 PUMP LINE

### NOTES: SOIL & WATER MANAGEMENT

1. ALL EROSION AND SEDIMENT CONTROL MEASURES TO BE INSPECTED AND MAINTAINED DAILY BY SITE MANAGER.

- 2. MINIMISE DISTURBED AREAS.
- 3. ALL STOCKPILES TO BE CLEAR FROM
- DRAINS, GUTTERS AND FOOTPATHS.
- 4. DRAINAGE IS TO BE CONNECTED TO STORMWATER SYSTEM AS SOON AS POSSIBLE.
- 5. ROADS AND FOOTPATH TO BE SWEPT DAILY.
- 6. NO MATERIAL TO BE STORED ON FOOTPATH. 7. IF YOU DO NOT COMPLY YOU MAY BE LIABLE TO A \$1500 FINE.